




CANCEL STATE OF THE STATE OF TH	COLUMN TO SERVICE	200	-		WHITE THE	1000	DG.
OC	Δ	TI	0	N	AA	Δ	ı

SITE	STATISTICS- 2	22 LEMARCHANT RD			
ZONING(ENVISION ST. JOHN'S DEVELOPMENT REGULATIONS AS AMENDED JULY 2024)		сон-сомм	ERCIAL OFFI	CE HOTEL	-
PROPOSED USE		4 STOREY A	PARTMENT B	UILDING	
ZONE STANDARDS (SECTION 10)		REQUIRED	EXI	STING	PROPOSED
LOT AREA(MINIMUM)	900 SQ.M.		6.657.03		6,657.03
LOT FRONTAGE(MINIMUM)		20 M	56.84		56.84
EXISTING BUILDING HEIGHT (MAXIMUM)	451.4		±9.55(EXISTING)		±9.55(EXISTING
BUILDING LINE(MINIMUM)-LEMARCHANT ROAD		61/4	±57.88{	EXISTING)	± 57.88 (EXISTING
EXTERIOR SIDE YARD (MINIMUM)	6M		±6,33 m(EXISTING)		±6,33 m(EXISTING
SIDE YARD(MINIMUM)	67.4		±12.27(EXI\$TING)		± 12.27(EXISTING
REAR YARD(MINIMUM)		6M	±4.12(EXISTING)		±4.12(EXISTING
LOT COVERAGE(MAXIMUM)		50%	16%		16%
LANDSCAPING(MINIMUM)		20%		7%	34%
COVERAGE CALCULATION		SM	SF		%
BUILDING AREA-EXISTING		1,059	11,403		16%
PAVED AREA		3,322.66	35	.765	50%
LANDSCAPED AREA-INCL SIDEW ALK	1	2,275.00	24,488		34%
SITE AREA	1	6,657.03	71	,656	100%
			REQUIRED		
PARKING CALCULATION(8.3)	UNITS	RATE	MIN.	MAX.	PROPOSED
WCRO UNIT-STUDIO	96	MIN 0 PARKING, MAX I PARKING/4 UNITS	0	24	
VICRO UNIT- 1 BEDROOM DW ELLING	2	MIN 0 PARKING, MAX 1 PARKING/4 UNITS	0	0.5	
I BEDROOM DWELLING	1	0.9-1.2	0.9	1.2	
VISITOR PARKING:		O VISITOR PARKING SPACES FOR THE FIRST 7 DW ELLINGS; I VISITOR PARKING SPACE PER 7 DW ELLINGS THEREAFTER	13.1	13.1	
OTAL	99		14.0	39	92
ARKING SURPLUS	<u> </u>	l	53	L	
ACC PARKING(Development Design Manual, 5.8.3)		RATE	REQU	JIRED	PROPOSED
OTAL ACCESSIBLE PARKING	6% OF THE TOTAL NO. OF PARKING		6		6
/AN-SIZED ACCESSIBLE PARKING)	1
CAR-SIZED ACCESSIBLE PARKING	 			5	5
PARKING AND DRIVE AISLE(Development Design Manual, 5.8.2)			REQUI	RED(m)	PROPOSED(m)
PO DEGREE STANDARD PARKING STALL			2.74X5.79		2.74X5.79
DRIVE AISLE WIDTH			7.		7.32
PARKING LOT BUFFER(B.B)			REQUI		PROPOSED(m)
ARKING LOT BUFFER FROM ANY STREET LINE(ROBERTS PLACE)					6
'ARKING LOT BUFFER FROM ANY STREET LINE(LEMARCHANT ROAD)					6.18
ARKING LOT BUFFER FROM ANY OTHER LOT LINE					±0.41(EXISTING)
OADING (8.10)			REQL		PROPOSED
OADING SPACE(10mL X 3.5mW X4.5mH)	 		1		1
ICYCLE PARKING(8.14)	 	RATE	REGU	IRED	PROPOSED
ICYCLE PARKING	I BICYCLE PARKING/2 RESIDENTIAL UNITS		50		50
ROSS FLOOR AREA			sq		SQ M
STFLOOR			11,4		
ND FLOOR			11,4		1,059
RD FLOOR			11,		1,059
			<u>-</u>	121	1,049
TH FLOOR			11,7	701	1,049

OIALGFA			l l
	SITE PLAI	N LEGEND	
	PROPERTY LINE		DEWO CURB
	EXECUTED EASEMENT (HYDRO)		FIRE POUTE
	EXCITING SITE TO PERAAM		EXISTING SIDEWALK
	PROPOSED SIDEWALK	-00	EXISTING FENCE TO REMAIN

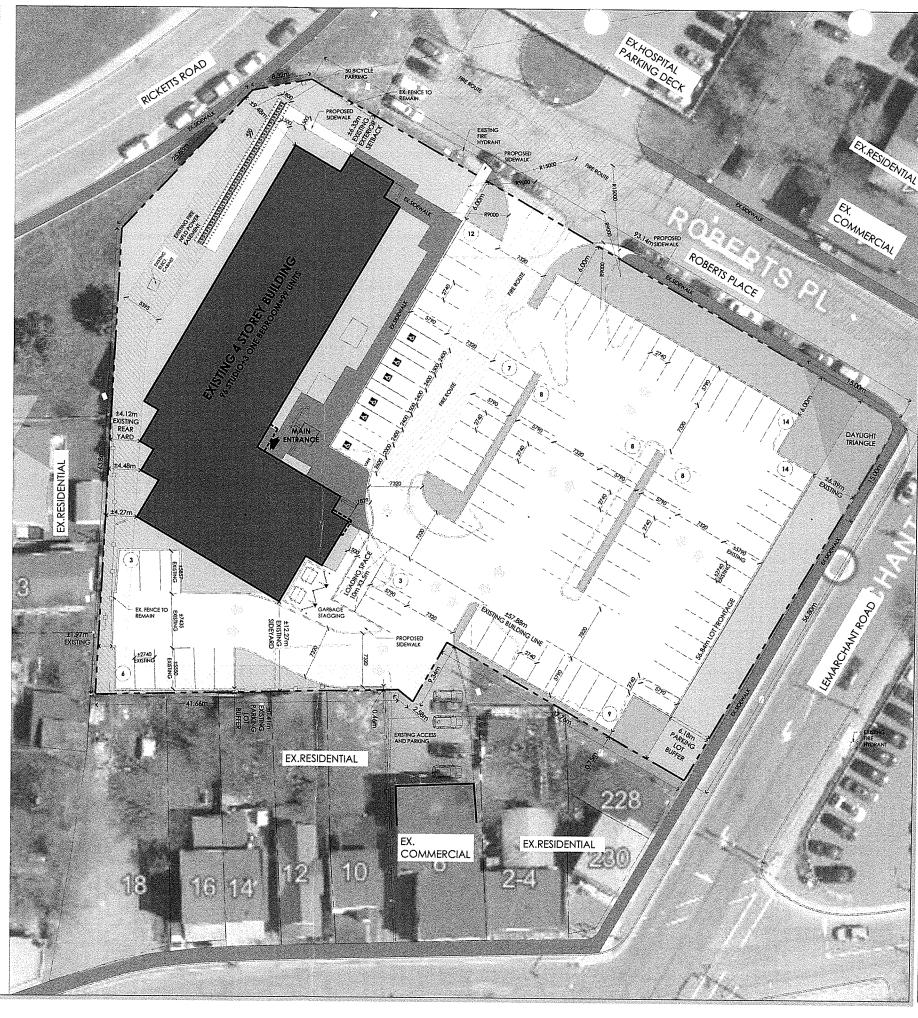

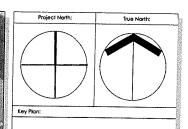

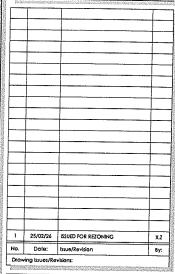

WORK IN PROGRESS

MATAJ

ST. JOHN'S RESIDENTIAL

220 LEMARCHANT RD, ST. JOHN'S, NL A1C 2H8

Sheet Title: SITE PLAN

	Design By:	Drawn 8y:	Approved By:	
	M.A	X.Z	M.A	
remanderence reman	Scale: 1:250	Date: 25/02/26	Project No.: 24-017	

ASP-1